





PLAN - CONTROL BUILDING
Scale : 1:100

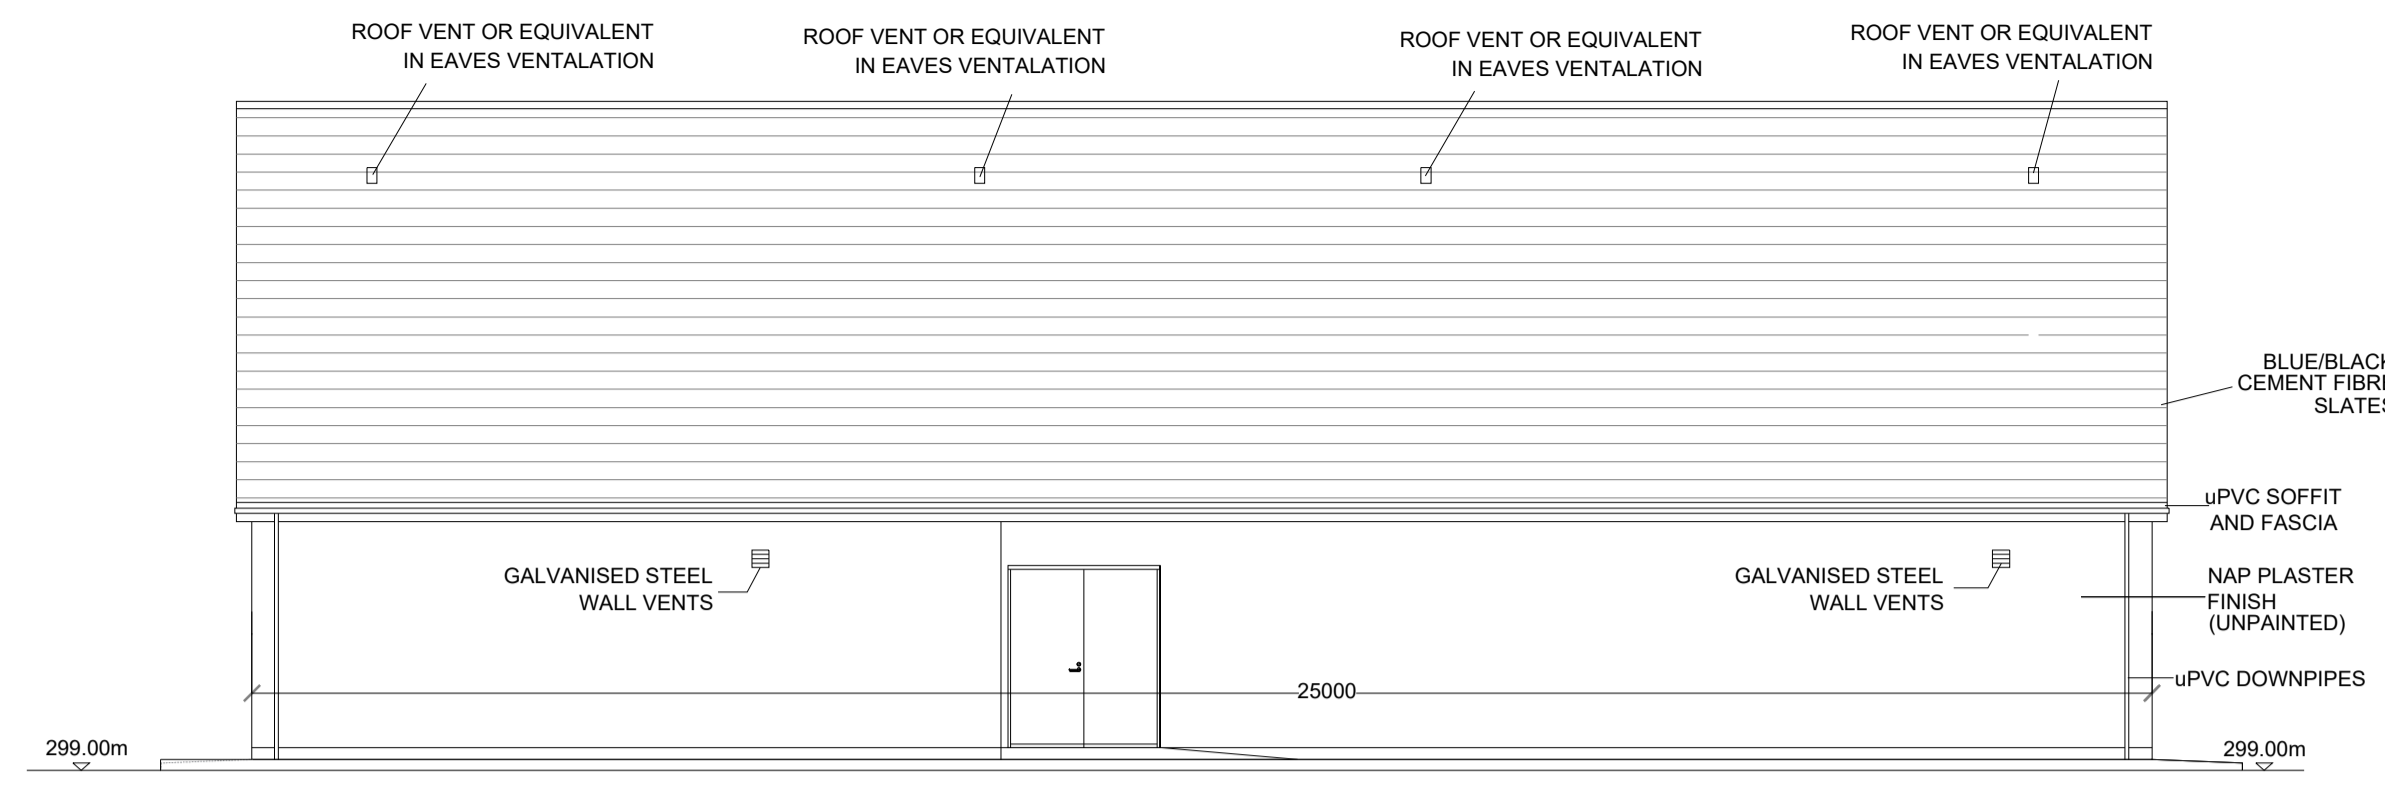


SOUTH EAST ELEVATION
Scale : 1:100

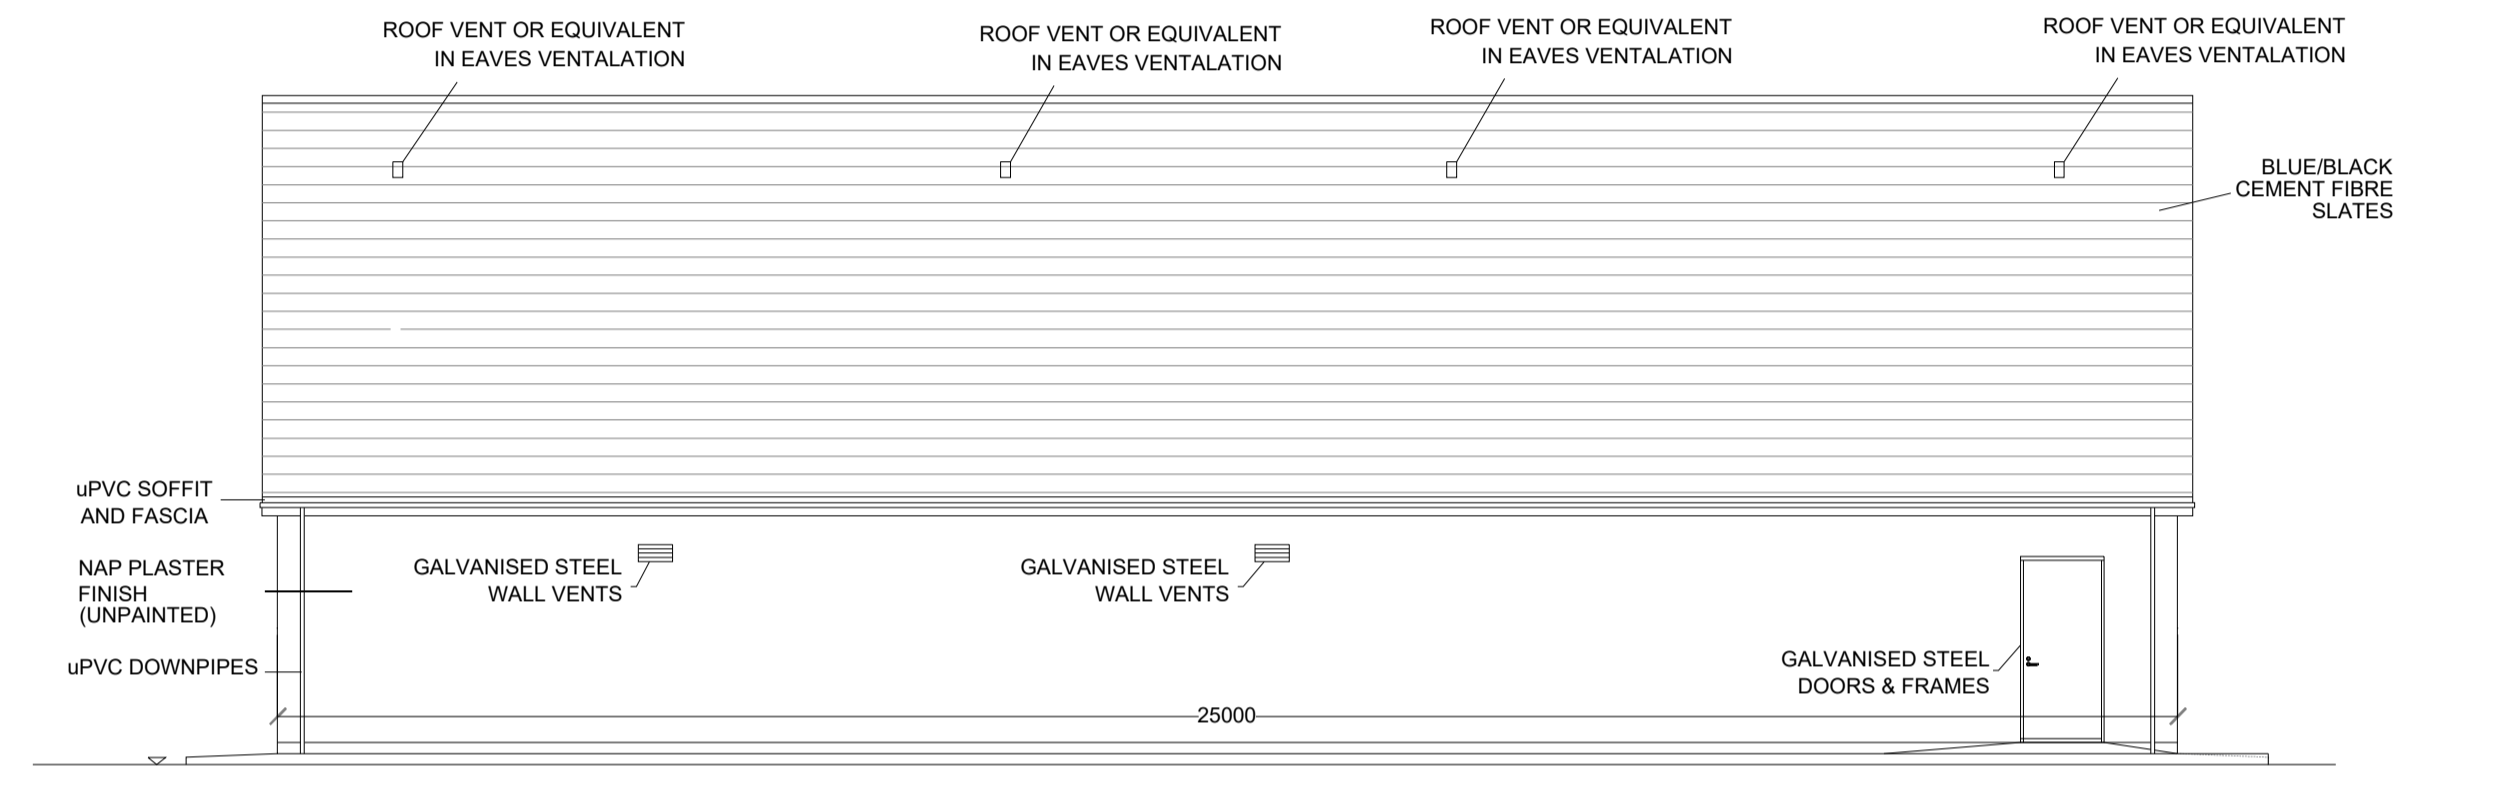

NORTH WEST ELEVATION
Scale : 1:100

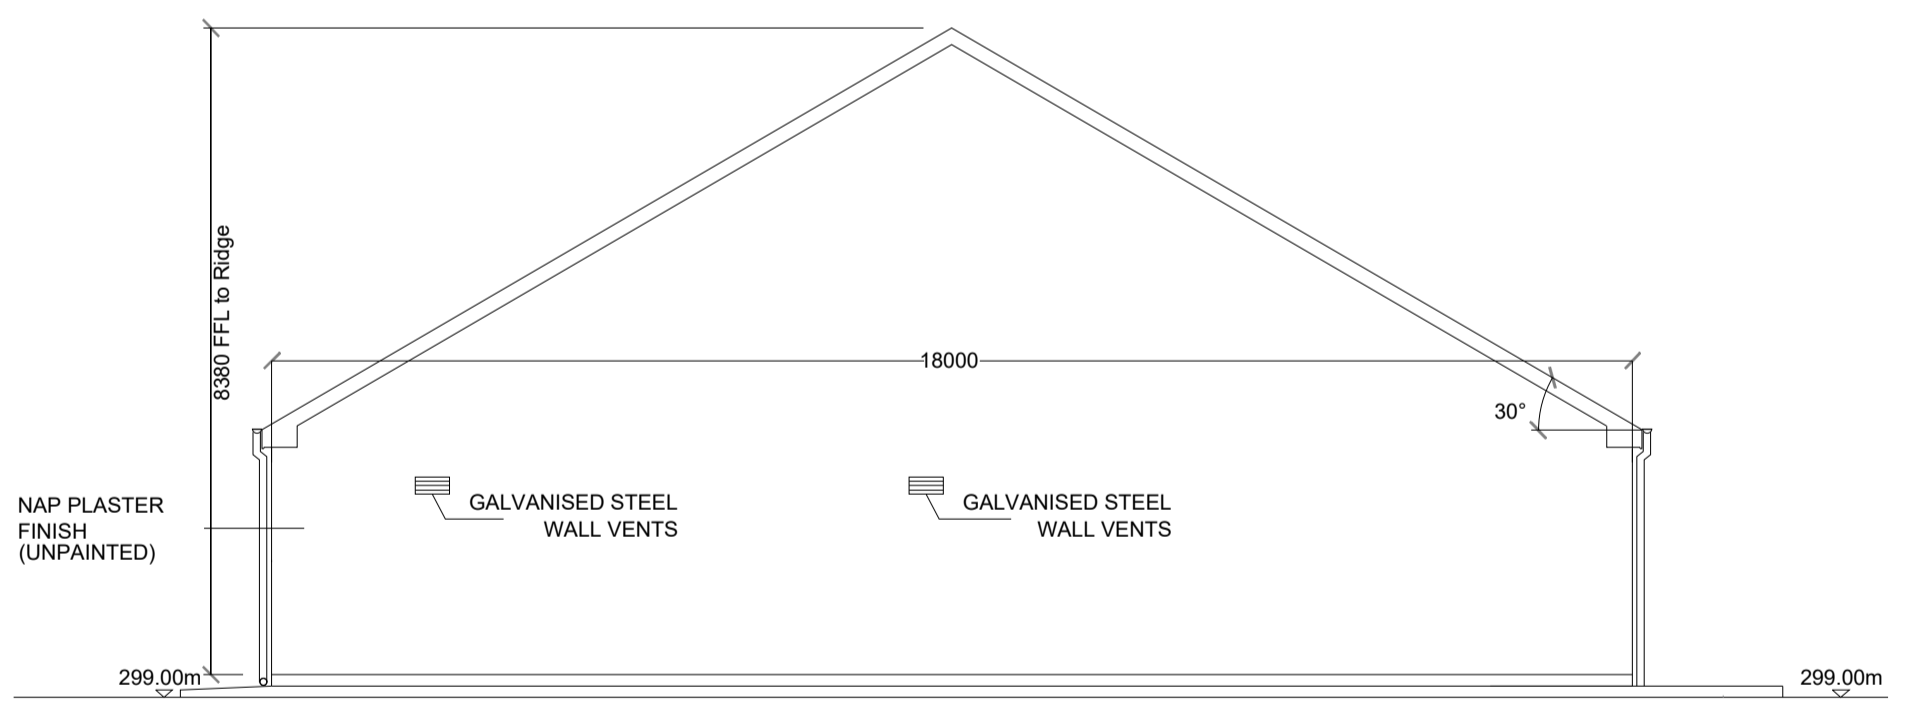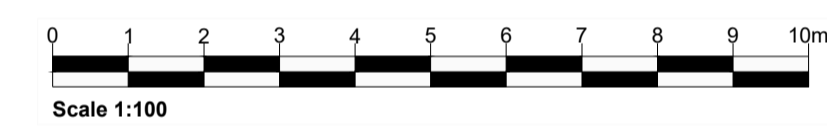


NORTH EAST ELEVATION
Scale : 1:100

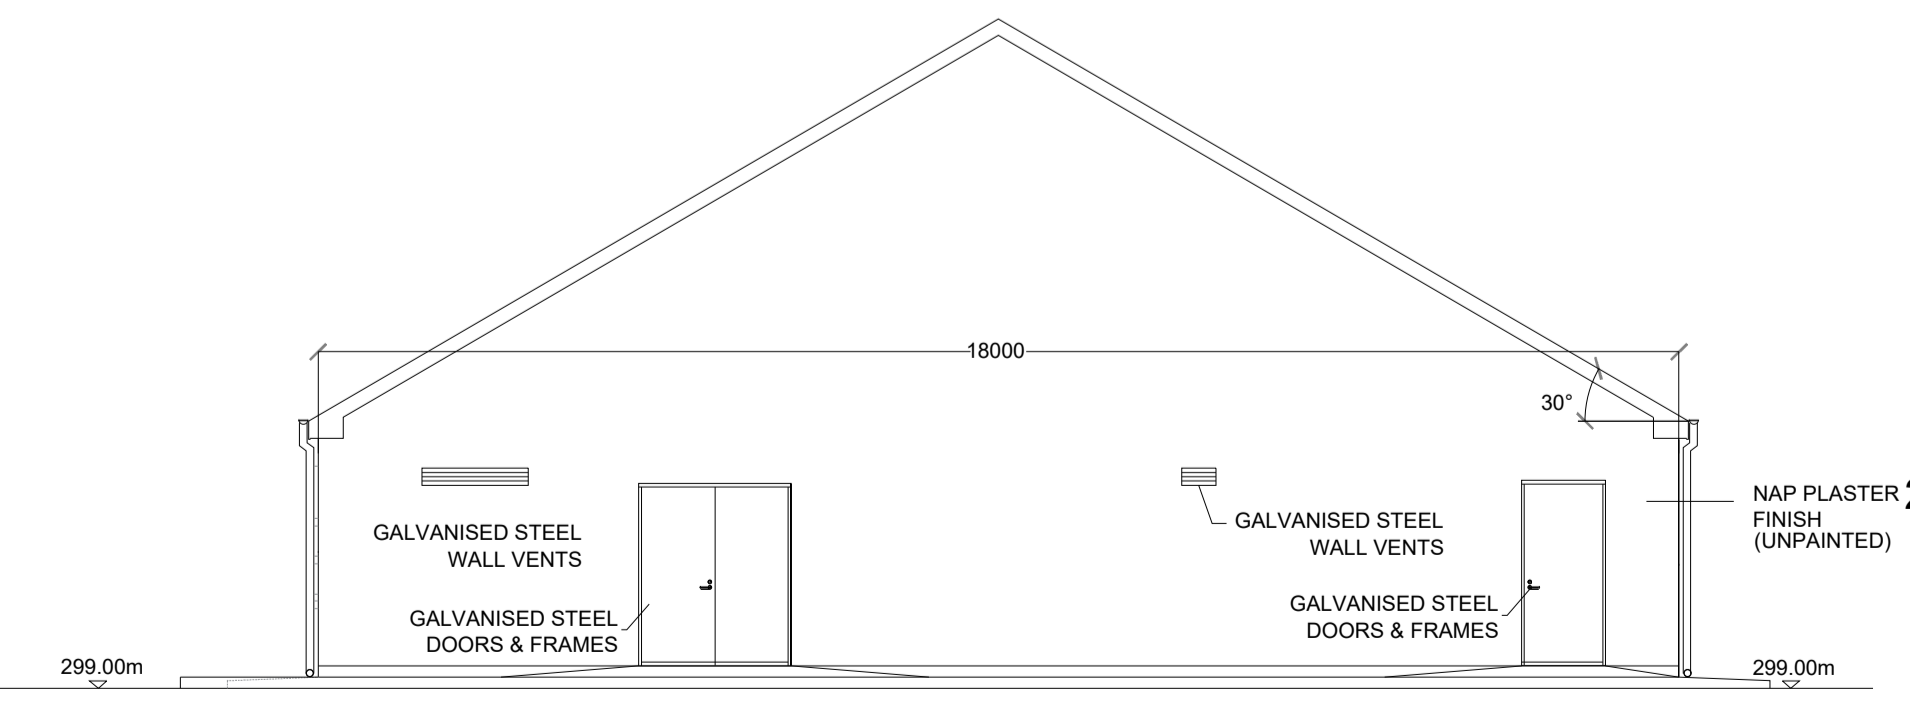


SOUTH WEST ELEVATION
Scale : 1:100

CAVITY WALL:
FLAT SAND / CEMENT PLASTER FINISH TO 100MM OUTER LEAF, 100MM CAVITY, 215MM INNER LEAF. INSIDE FACE OF INNER LEAF TO REMAIN FAIR-FACED. CAVITY WALL SUPPORTED ON CONCRETE STRIP FOUNDATION.

ROOF CONSTRUCTION:
ROOF SLATE ON TREATED SW ROOF BATTENS ON SELECTED BREATHER MEMBRANE ON SELECTED SW PREFABRICATED ROOF TRUSS SYSTEM FIXED TO TREATED 100X75MM SW WALLPLATE. INTERNAL CEILING TO BE 200MM HOLLOWCORE SLAB FOR SECURITY PURPOSES.

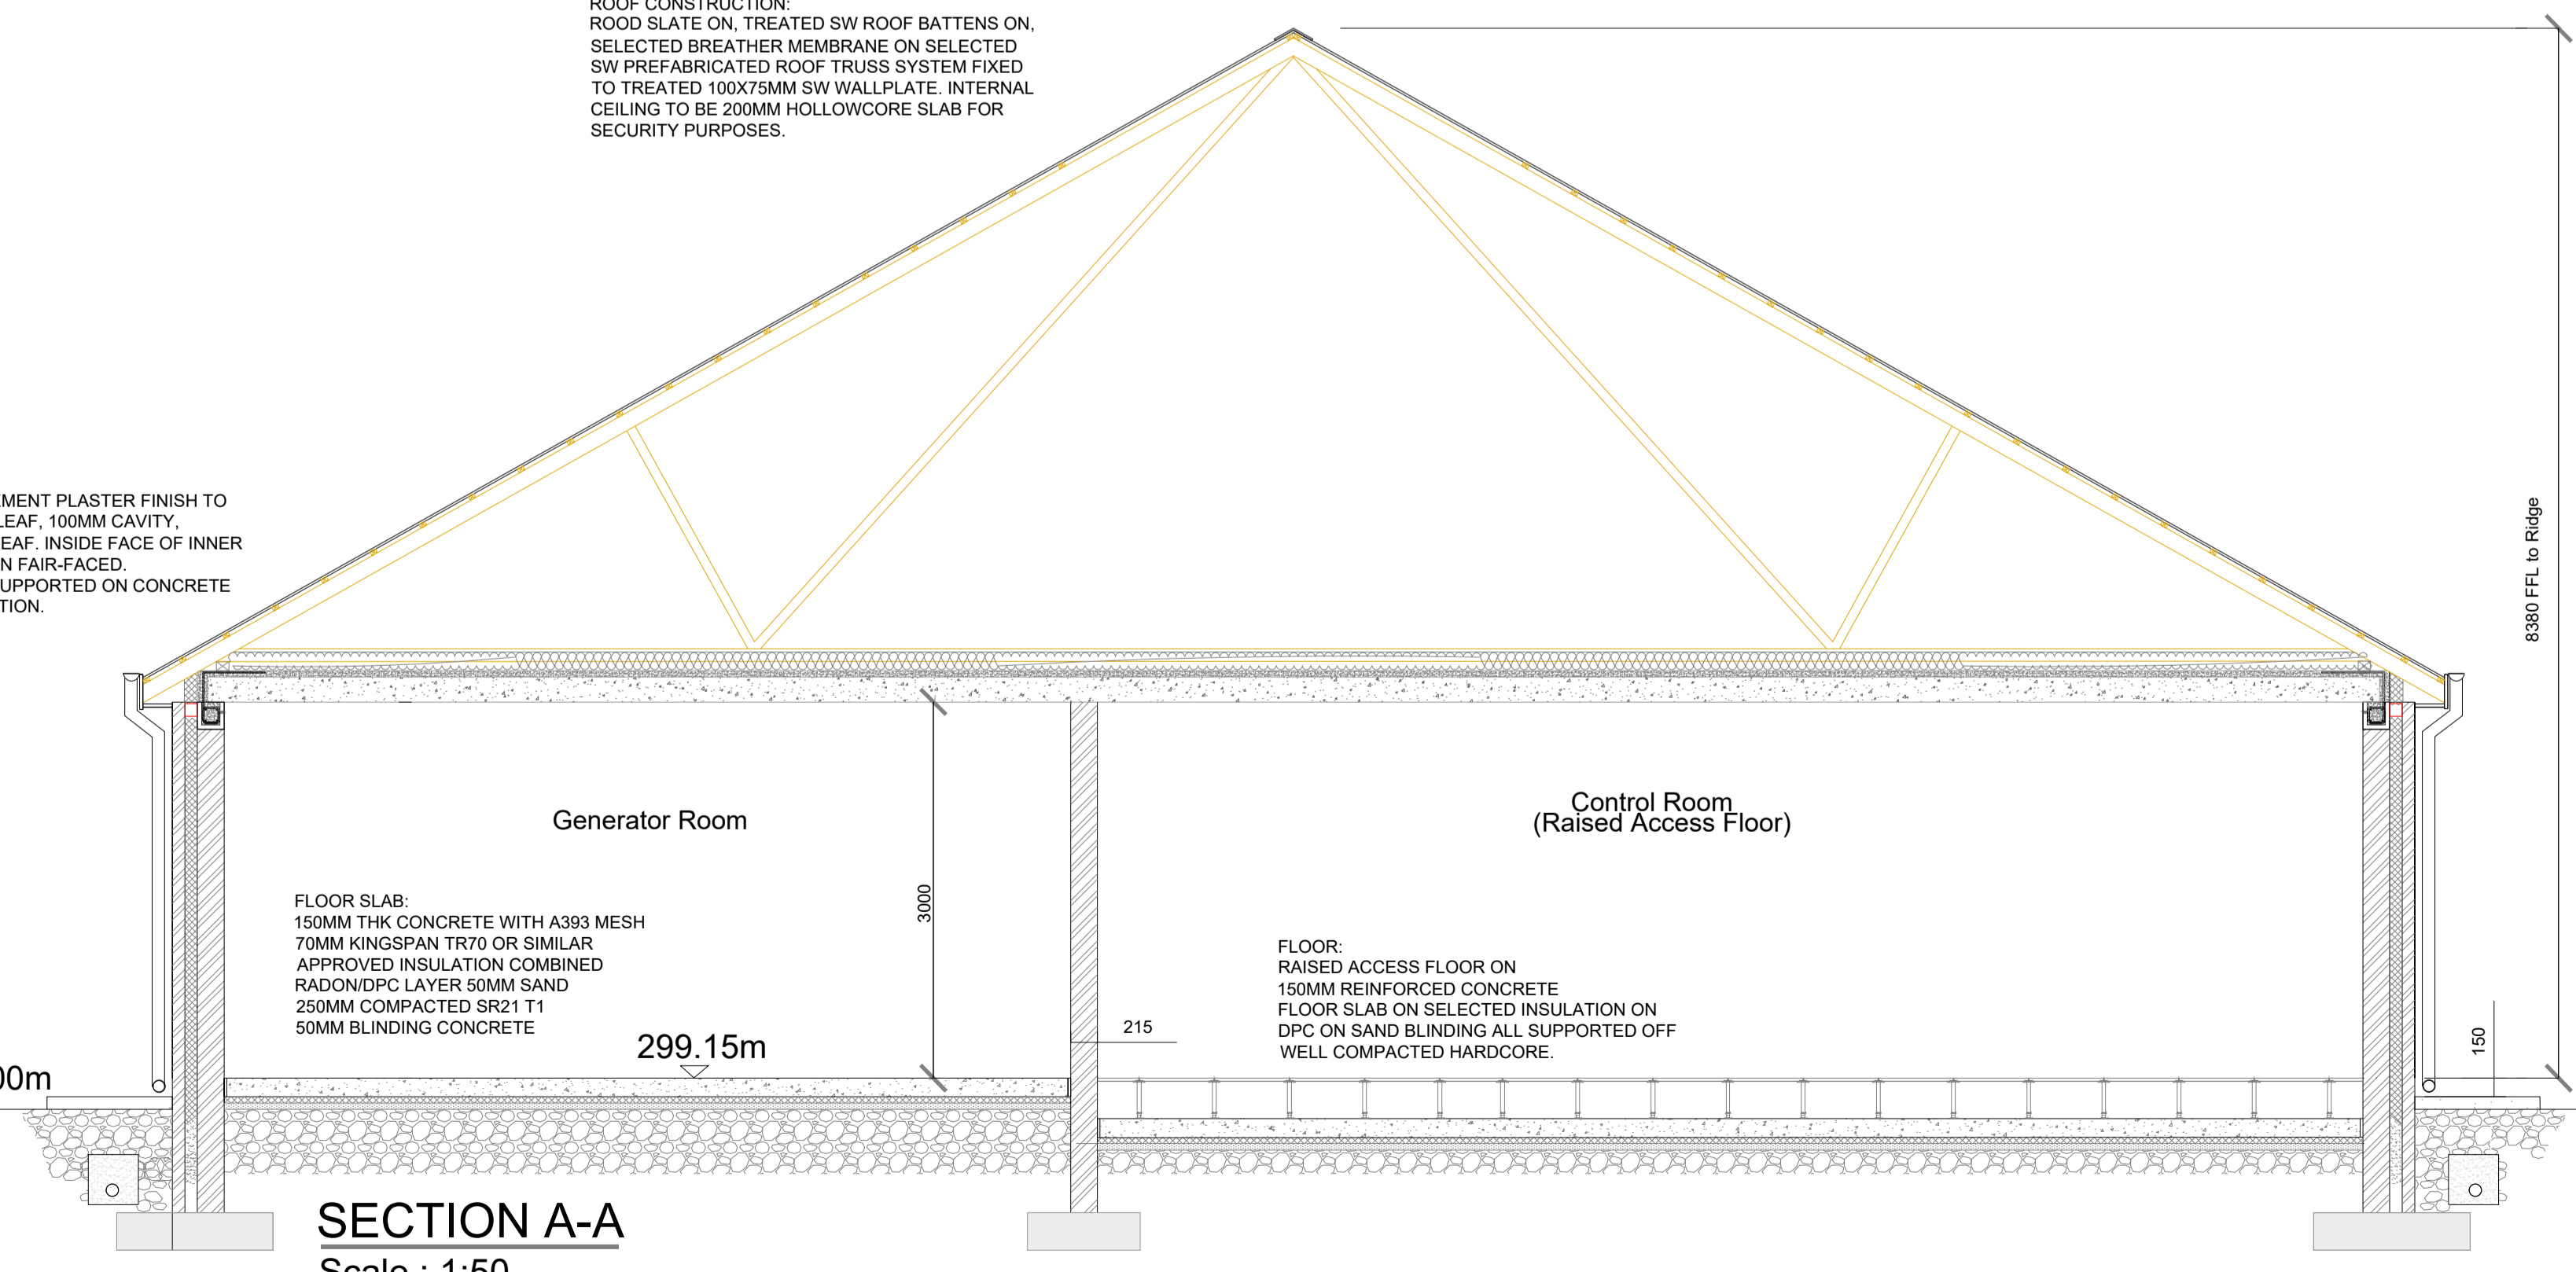

SECTION A-A
Scale : 1:50

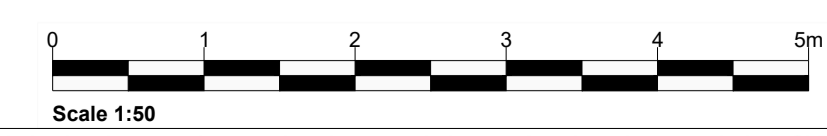

- Notes:**
1. Configuration of substation equipment and infrastructure is subject to ESB and EIRGrid design approval.
 2. The proposed substation layout should be used for planning purposes only.
 3. This drawing is to be read in conjunction with relevant drawings, specifications and reports.
 4. Dimensions are in millimetres, unless noted otherwise.
 5. Drawings are not to be scaled. Use figured dimensions only.
 6. All levels are shown in metres above ordnance datum.

Legend:

Rev	Amendments	Date	By	Chk	Auth
1	GENERAL UPDATES	07/23	LB	GO	SM
0	PLANNING APPLICATION	06/23	IG	MM	CL



www.slrconsulting.com

Drawing Status & Suitability Code

Client
COOLGLASS WIND FARM LIMITED

Project
COOLGLASS WIND FARM

Drawing Title
CONTROL BUILDING - PLAN, ELEVATIONS AND SECTION

Scale	AS SHOWN	@ A1	SLR Project No.	428.V02036.00787
Designed	CL	IG	Checked	MM
Date	06/23	06/23	Date	06/23

Authorised <td>CL</td>	CL
Date	06/23

Drawing Number	ABP-V02036.00787.036	Rev	1
----------------	----------------------	-----	---

03/08/2023
M:\a\6\ED\FS-E\Projects\02\036 - SLR Ireland\00787 Fosy EIART\Tech\CSE\Drawings\Wing\Planning Drawings - June 2023\ABP-428.V02036.00787.036_1_Control_Building.dwg